



Zero Emission Vehicle Transition Plans



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W

Wendel has a strong practice in the **transportation sector** and provides planning, design and execution services for **Battery Electric Vehicles, charging infrastructure and operation facilities.**

Wendel also has a strong **alternative fuels** group that provides consulting services for propane, compressed natural gas, battery electric vehicles and hydrogen fueled vehicles.



ARCHITECTURE
INTERIOR DESIGN
LANDSCAPE
ARCHITECTURE



ENGINEERING
CIVIL
ELECTRICAL
ENVIRONMENTAL
MECHANICAL
MUNICIPAL
STRUCTURAL
TRANSPORTATION
RAILROAD
ALTERNATIVE
FUEL SOLUTIONS
WATER/
WASTEWATER
RETROFITS
LAND SURVEYING
GEOGRAPHIC
INFORMATION
SYSTEMS (GIS)
PLANNING



ENERGY
EFFICIENCY
ENERGY AUDITS
COMMISSIONING
PROFESSIONALLY
ASSISTED
PERFORMANCE
CONTRACTING
ALTERNATIVE
FUNDING/GRANT
PROGRAMS
RETROFIT AND
IMPLEMENTATION
DESIGN
GREEN BUILDING
DESIGN
MEASUREMENT &
SAVINGS
VERIFICATION
(M&V)
RENEWABLE
TECHNOLOGIES



CONSTRUCTION
MANAGEMENT
MASTERBUILDER
PROGRESSIVE
DESIGN/BUILD
DESIGN/BID/BUILD
CONSTRUCTION
MANAGEMENT AT
RISK(CMAR)
CM AGENT
GMP
DESIGN/BUILD



**300+
Employees**

**16 Offices
Nationwide**

A Trusted Advisor

Wendel's depth of expertise in alternative fuels has made us a trusted advisor to many companies.

- Former **utility employees** on staff.
- Experts in **fire protection** for lithium-ion battery fires.
- Provide technology and **vendor-neutral options**.
- Work with various agencies to find funding through federal, state, local, and utility **grants and incentives**.



Wendel's John Havrilla presenting an overview of zero-emission transition plans for school districts at a recent NYSERDA/Wendel joint presentation to school superintendents at Lakeshore High School.

Wendel often presents at industry conferences with NYSERDA and school districts on battery electric bus transition issues and initiatives.



Experienced Technical Partnership

- Currently working with over 135 NYS School districts
- Over 3,700 buses included in current projects
- Projects include:
 - Fleet Electrification Plans (FEPs)
 - Pilot projects
 - FEP implementation design
 - Construction management/support





Zero-Emission Bus Mandate

- By **2027** all new school bus purchases need to be zero-emissions. By **2035** all school buses on the road need to be zero-emissions.
- The Senate is requiring the state to identify barriers to the 100% by **2035** goal so that they may be resolved early.
- New York State Energy Research and Development Authority (NYSERDA) is being tasked to provide technical assistance to school districts as they navigate the transition to 100% electric buses.
- Amendments – **two 2-year extensions** to the 2027 deadline. NYS SED developing application process and qualification criteria by 12/31/2025

Zero Emission Vehicle Transition Plan Goals



Provide path towards Zero Emission fleet by 2035 & ensure seamless transition



Evaluate & recommend infrastructure upgrades



Provide information to the District in order to make informed decisions regarding design/implementation



Reduction of energy loads and assist in conversion to carbon free fuels



Identify constraints a district may face in meeting the required mandates





Typical Scope of Work

The Zero Emission Vehicle Transition Plan Consisted of the Following Tasks:

- TASK 1** – Project Kickoff and Status Meetings
- TASK 2** – Data Collection
- TASK 3** – Route Analysis
- TASK 4** – Conceptual Charging Strategy
- TASK 5** – Electrical Utility Analysis
- TASK 6** – Concept Development and Phasing Plan
- TASK 7** – Transition Plan Cost Estimates
- TASK 8** – Final Report and Presentation

Battery Electric Bus Options

(NOT ALL INCLUSIVE)

Blue Bird



Thomas Built



IC Bus



Lion



Standard Battery Size:	155 kWh	244 kWh	210 kWh	126 kWh
Operating Range:	120 miles	150 miles	155 miles	100 - 155 miles
Battery Type:	Li-NMC-G	Li-NMC-G	Lithium-ion	Li-NMC-G
Charge Options:	AC Level 2 & 3	AC Level 2 & 3	AC Level 2 & 3	AC Level 2 & 3
Drive Train:	Cummins	Proterra		
Additional Options:			315 kWh Battery	168 kWh Battery
			Diesel Heater	210 kWh Battery

Utility Requirements

- Charging battery electric buses requires additional power from the utility.
- New service feed and additional transformer may be required from the local utility.
- Can the local utility supply the required power for this project?
- What are the costs the district will incur to upgrade the utility infrastructure to serve the district? (up to 100% of these costs could be covered by Make Ready Programs)
- Low voltage service (traditional) or medium voltage service



NYSERDA Fleet Electrification Planning

Fleet Electrification Plan (FEP) Funding Opportunities

NYSERDA provides funding to support the completion of FEPs, amounts depend on the applicant. The following funding percentages, or cost-shares' are provided by NYSERDA:

- 100% of costs covered by NYSERDA for NYSBIP Priority Districts
- 75% of the costs covered by NYSERDA for non-Priority Districts
- A minimum of 50% of the costs covered by NYSERDA for third-party bus operators



NYSERDA Programs: Funding

NEW YORK SCHOOL BUS INCENTIVE PROGRAM

The NYSBIP is an incentive program that provides grants to a school district or group of school districts to offset all or a portion of the purchase price of new or repowered Electric School Bus(es) and associated Charging Infrastructure .

\$500M allocation from the
Environmental Bond Act



Grants and Incentives: School Buses

School Bus Type Base	Base Voucher	Priority District Bonus	Scrappage Bonus	Wheelchair Add-on
New Type A	\$114,000	\$28,500	\$47,500	\$8,000
New Type C	\$147,000	\$36,750	\$61,250	\$8,000
New Type D	\$156,000	\$39,000	\$65,000	\$8,000
Repowered A	\$105,000	\$21,000	N/A	N/A
Repowered C	\$135,000	\$27,000	N/A	N/A

State: New York School Bus Incentive Program – School Bus Voucher

Federal: Inflation Reduction Act Commercial Clean Vehicle Tax Credit (45W)

- Up to \$40,000 per vehicle

Grants and Incentives: Chargers

Type	Base Voucher Amount per Bus	Fleet Electrification Plan Bonus per Bus
Non-Priority District	\$25,000	\$55,000
Priority District	\$35,000	\$65,000

State: New York School Bus Incentive Program – Charging Voucher

State: Joint Utilities of New York Medium- and Heavy-Duty EV Make-Ready Pilot

- 100% of the utility-side infrastructure costs covered (Cap at \$100,000)
- Up to 20% of customer side costs covered for Non-DAC or (Cap at \$50,000).

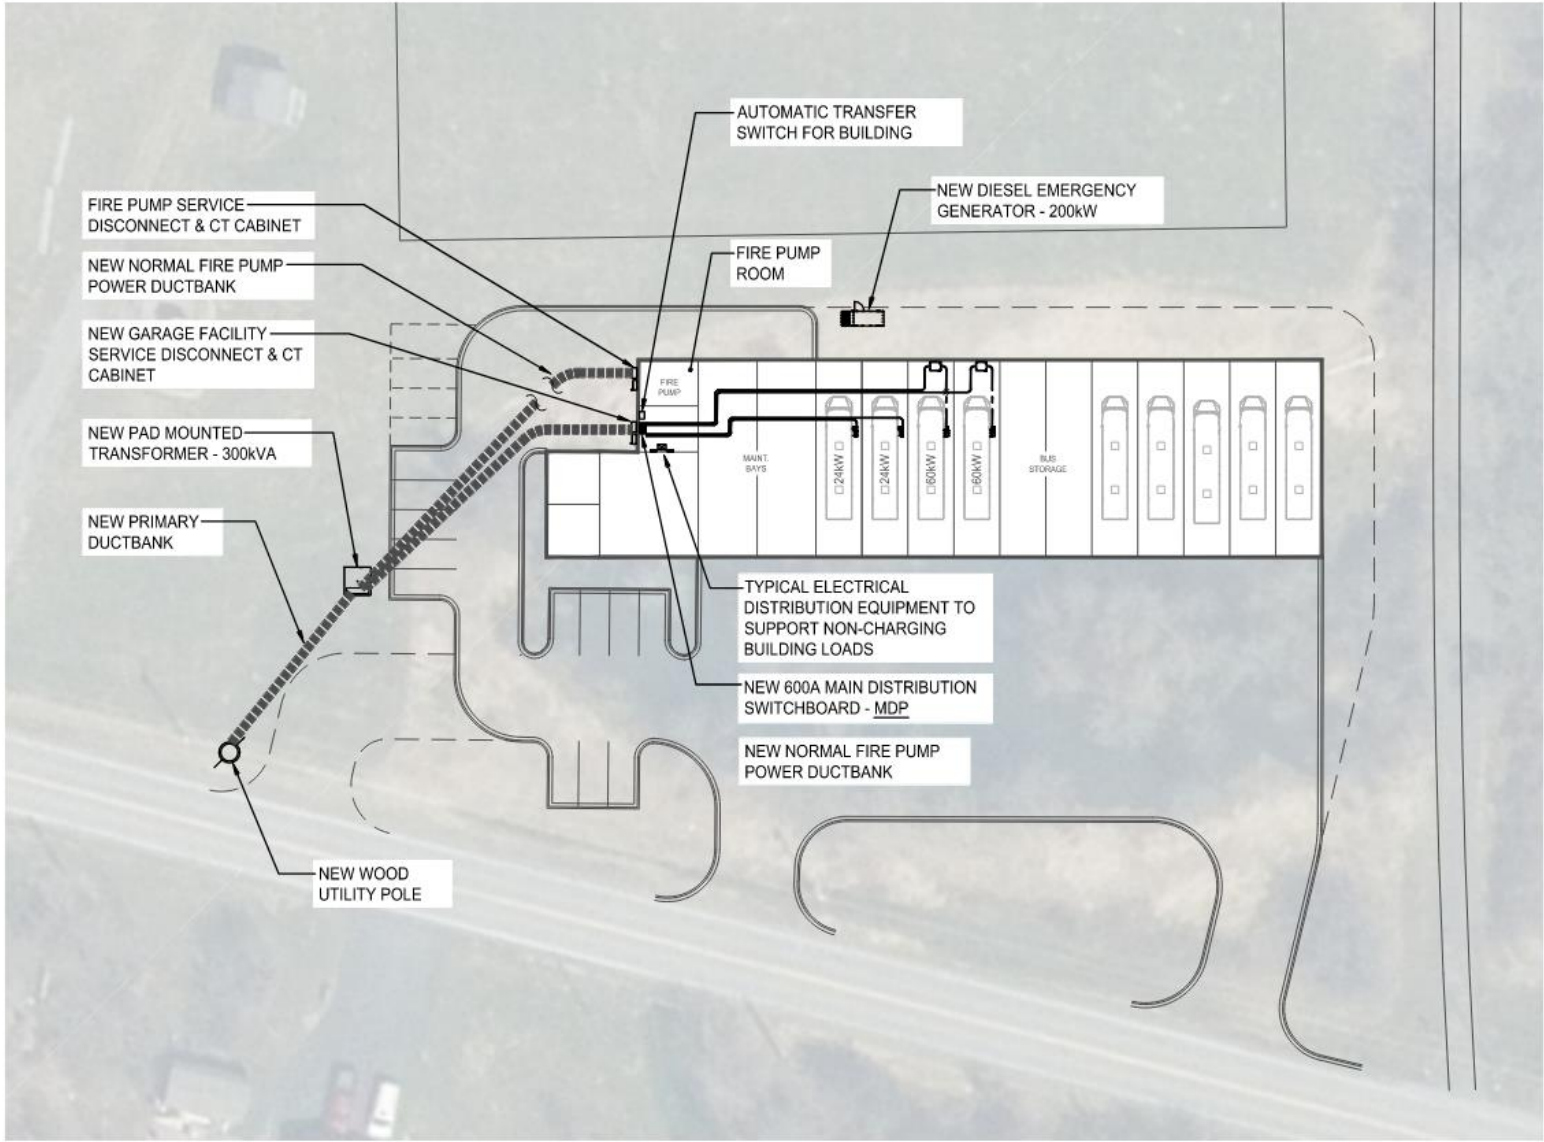
Federal: Inflation Reduction Act Funding Alternative fuel vehicle refueling property credit (30c)

- 30% (up to \$100,000 per property item) for alternative fuel charging stations



Proposed Bus Facility

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CHARGER QUANTITY

PHASE 1	24kW PLUG-IN	2
	60kW PLUG-IN	2
	120kW PLUG-IN (# OF DISP.)	-
	-	-
TOTAL AFTER PHASE 1		4
TOTAL CHARGING POSITIONS AFTER PHASE 1		4

1 SITE PLAN LAYOUT - PHASE 1
SCALE: 1"=40'-0"

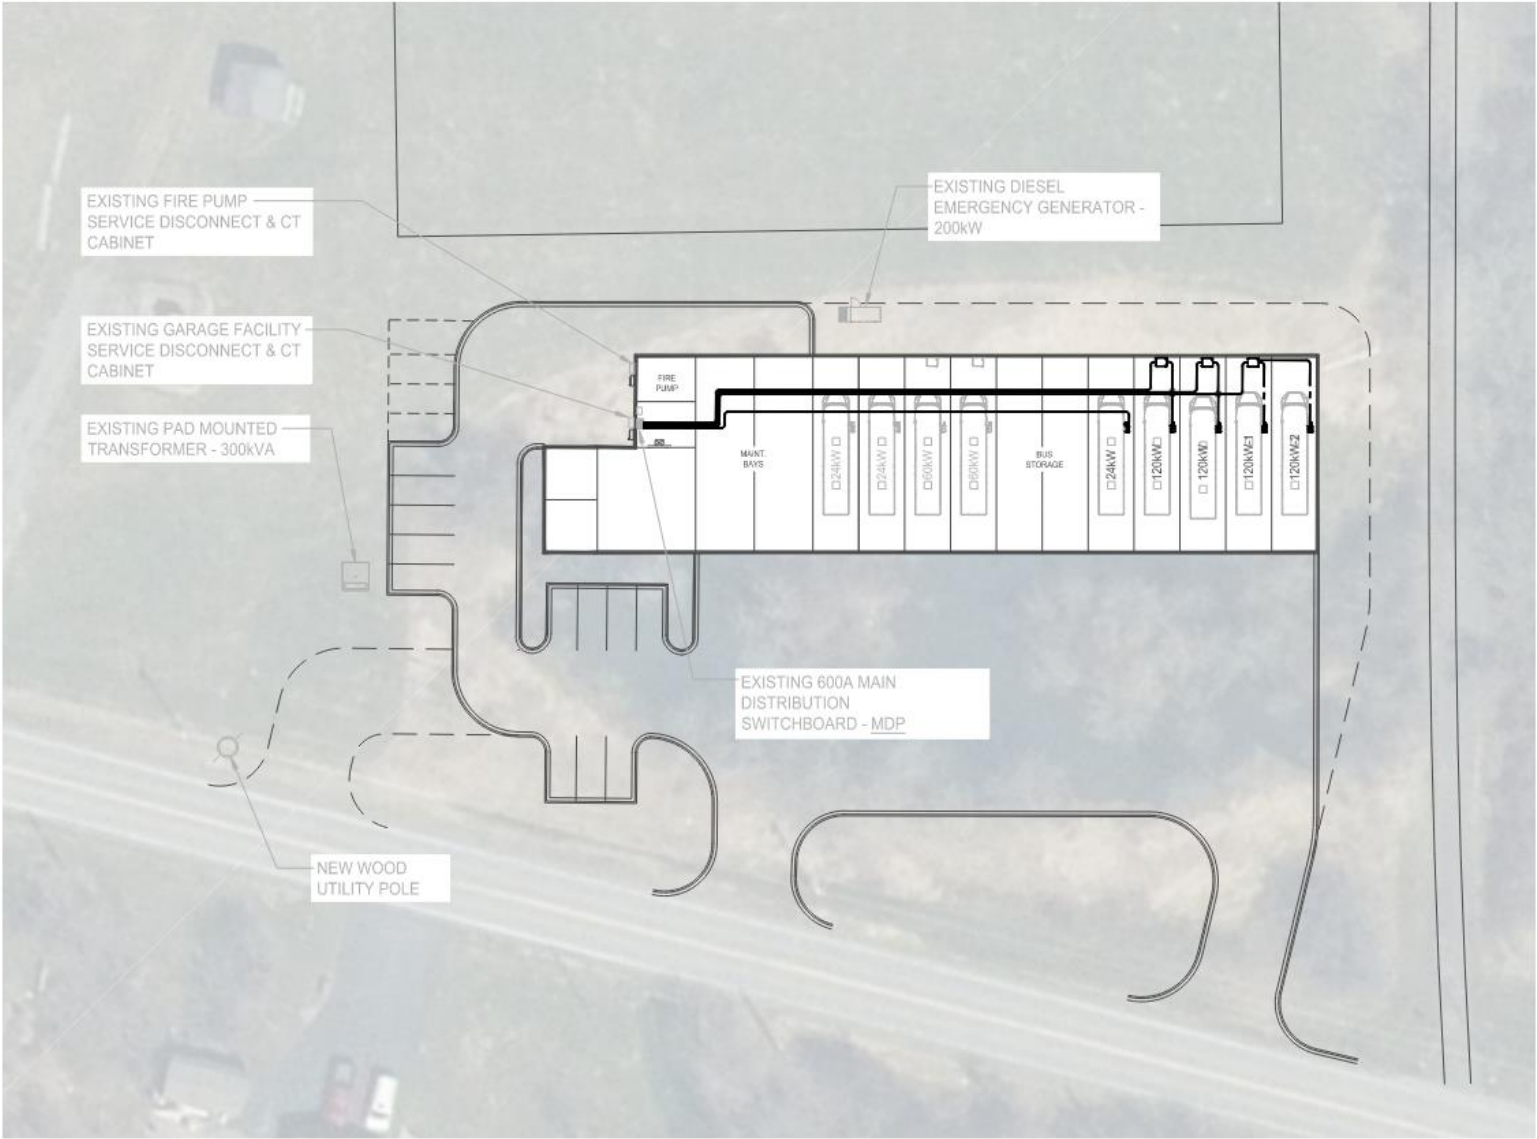
CONCEPTUAL - NOT FOR CONSTRUCTION



Charging Equipment Layout -
Phase 1

Proj. No.	632401
Date	10/07/2024
Drawing Number	E1

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CHARGER QUANTITY

PHASE 1	24kW PLUG-IN	2
	60kW PLUG-IN	2
	120kW PLUG-IN (# OF DISP.)	-
PHASE 2	24kW PLUG-IN	1
	60kW PLUG-IN	-
	120kW PLUG-IN (# OF DISP.)	1(2)
	120kW PLUG-IN (# OF DISP.)	2(1)
	TOTAL AFTER PHASE 2	8
	TOTAL CHARGING POSITIONS AFTER PHASE 2	9

1 SITE PLAN LAYOUT - PHASE 2
SCALE: 1"=40'-0"

CONCEPTUAL - NOT FOR CONSTRUCTION

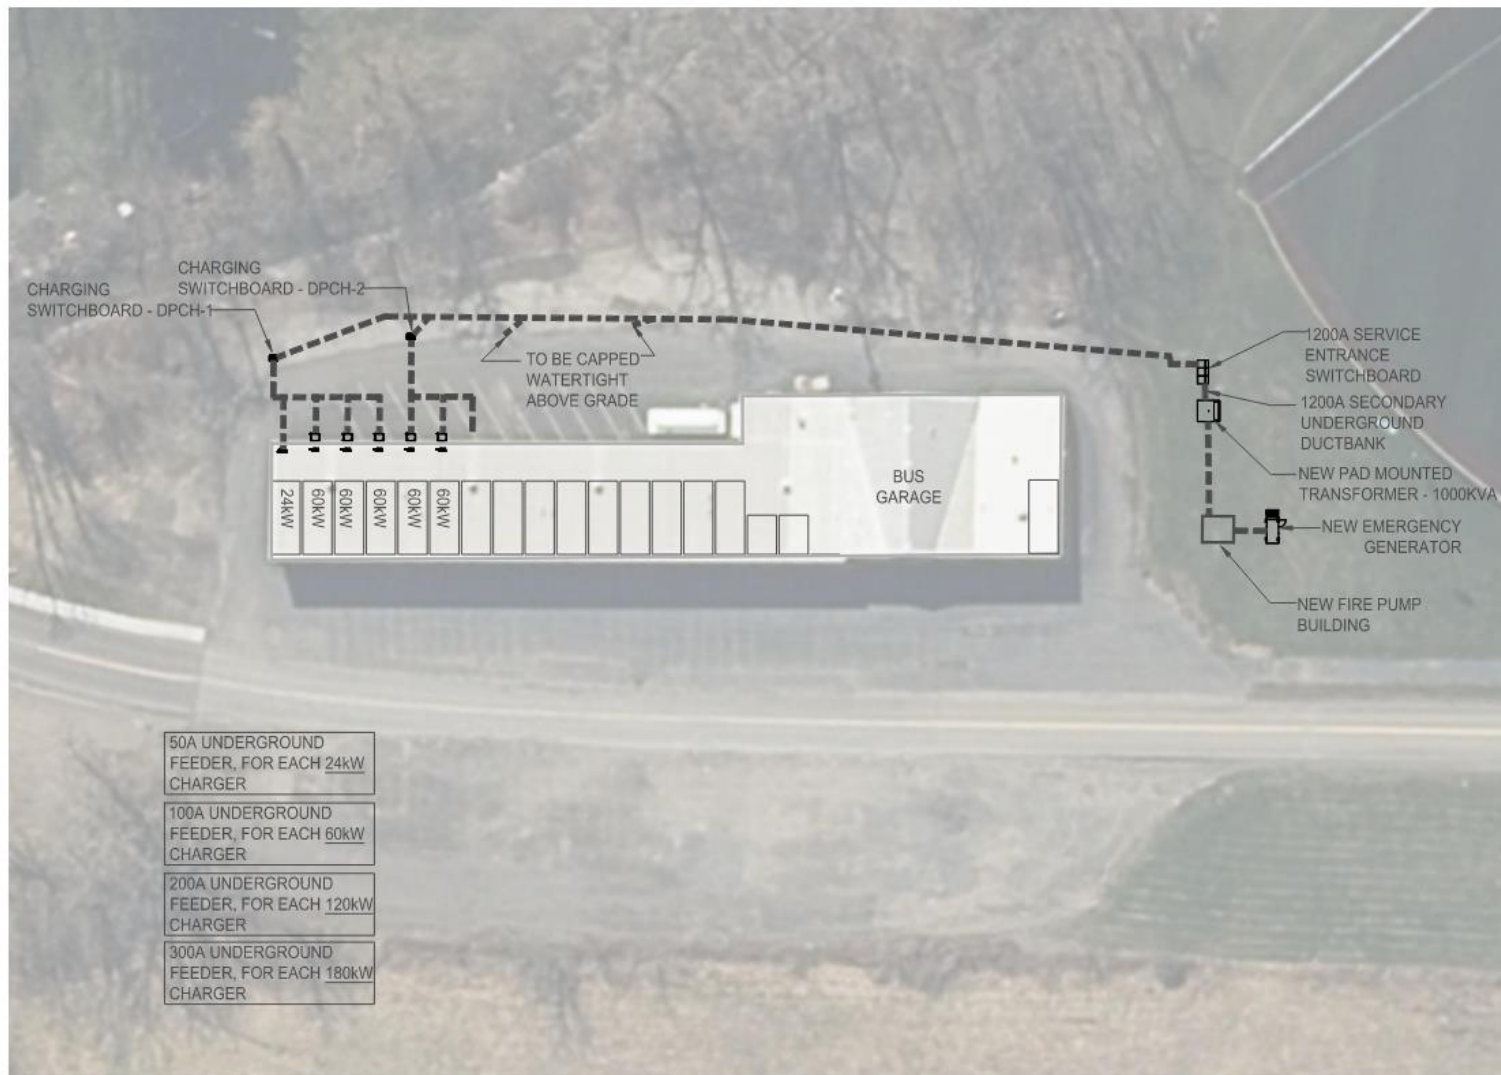


Charging Equipment Layout -
Phase 2

Proj. No.	632401
Date	10/07/2024
Drawing Number	E2

CHARGER QUANTITY

24kW PLUG-IN	1
60kW PLUG-IN	5
120kW PLUG-IN	-
180kW PLUG-IN	-
-	-
TOTAL AFTER PHASE 1	6



1 SITE PLAN LAYOUT - PHASE 1 (2027-2030)
SCALE: 1"=50'-0"

CONCEPTUAL - NOT FOR CONSTRUCTION

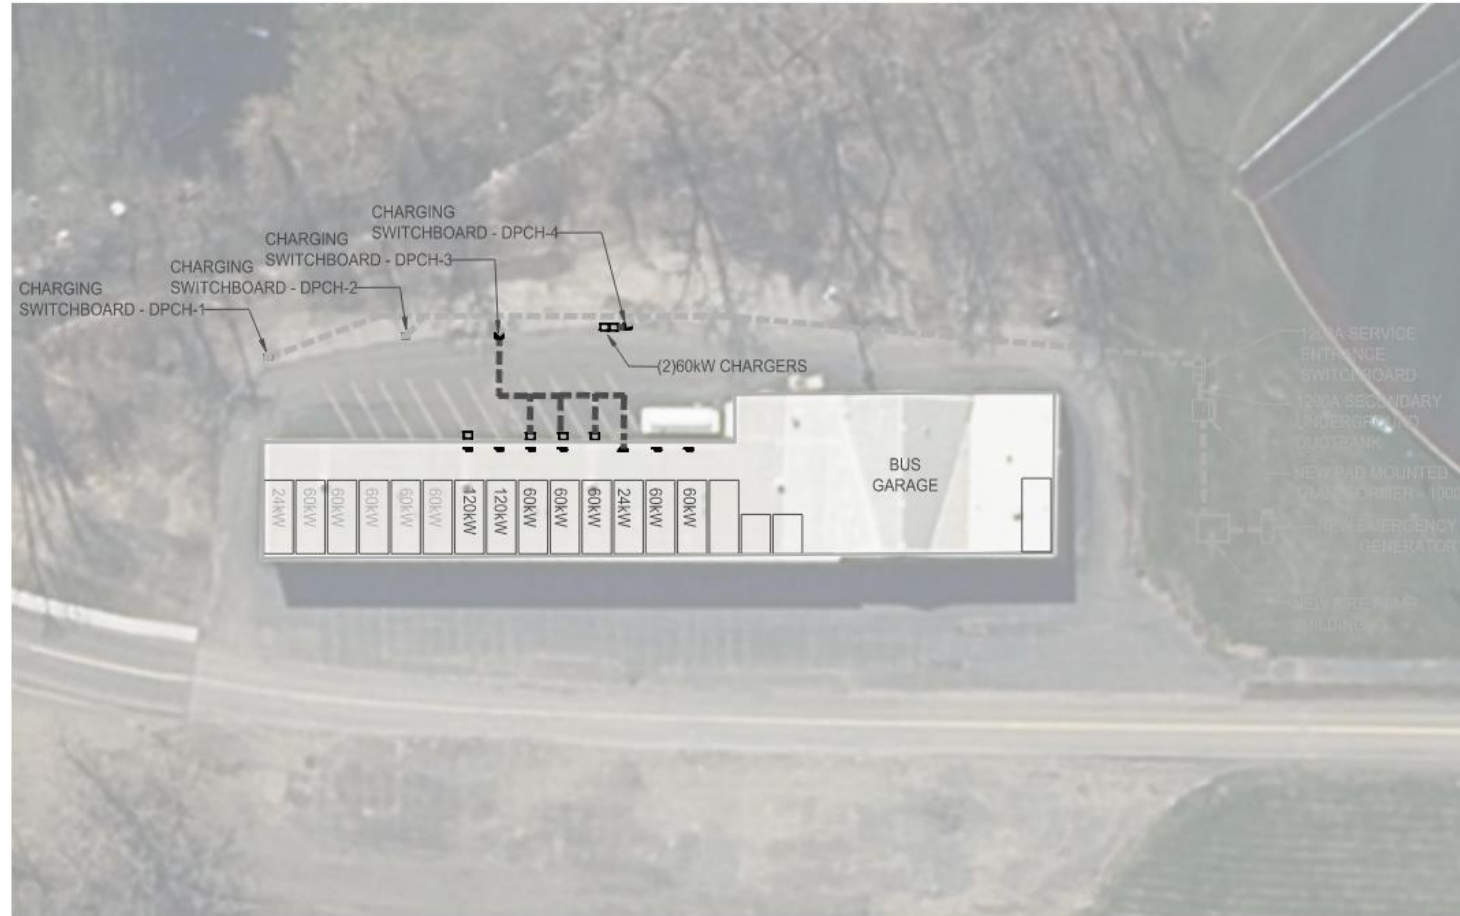


Charging Equipment Layout -
Phase 1

Proj. No.	633501
Date	07/31/2024
Drawing Number	E1



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- 50A UNDERGROUND FEEDER, FOR EACH 24kW CHARGER
- 100A UNDERGROUND FEEDER, FOR EACH 60kW CHARGER
- 200A UNDERGROUND FEEDER, FOR EACH 120kW CHARGER
- 300A UNDERGROUND FEEDER, FOR EACH 180kW CHARGER

CHARGER QUANTITY

PHASE 1	24kW PLUG-IN	1
	60kW PLUG-IN	5
	120kW PLUG-IN	-
	180kW PLUG-IN	-
PHASE 2	24kW PLUG-IN	1
	60kW PLUG-IN	5
	120kW PLUG-IN	1(2:1)
	180kW PLUG-IN	-
TOTAL AFTER PHASE 2		13

1 SITE PLAN LAYOUT - PHASE 2 (2031-2033)

SCALE: 1"=50'-0"

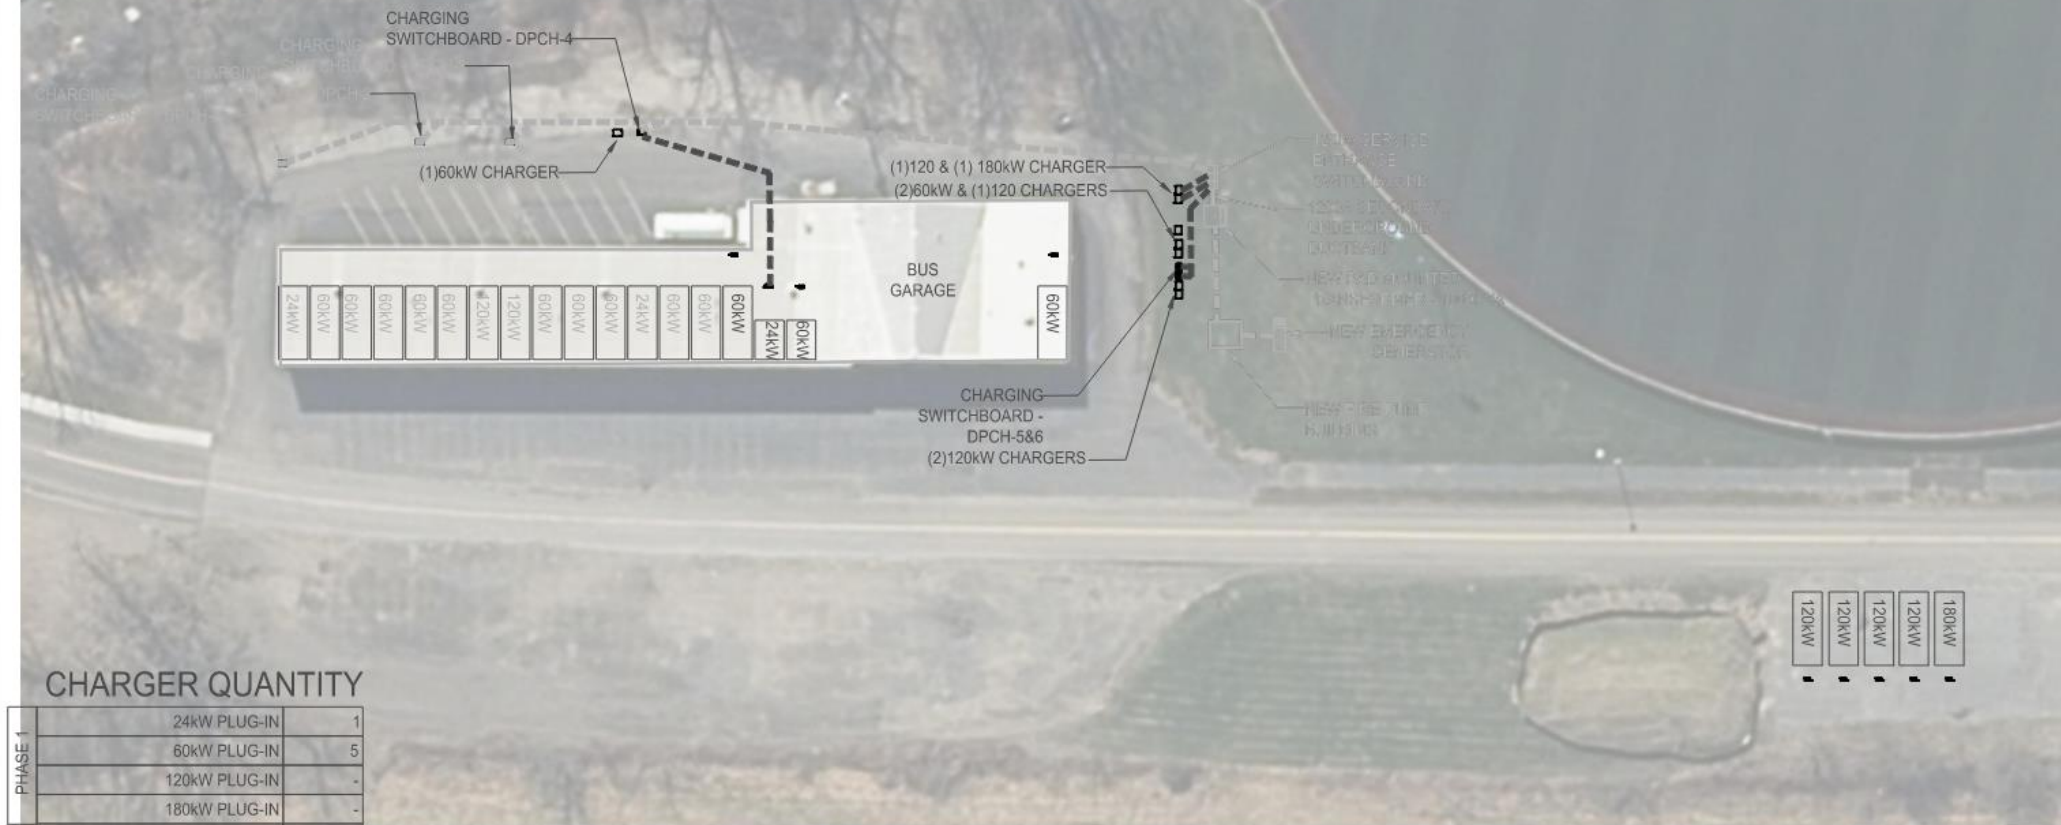
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Charging Equipment Layout -
Phase 2

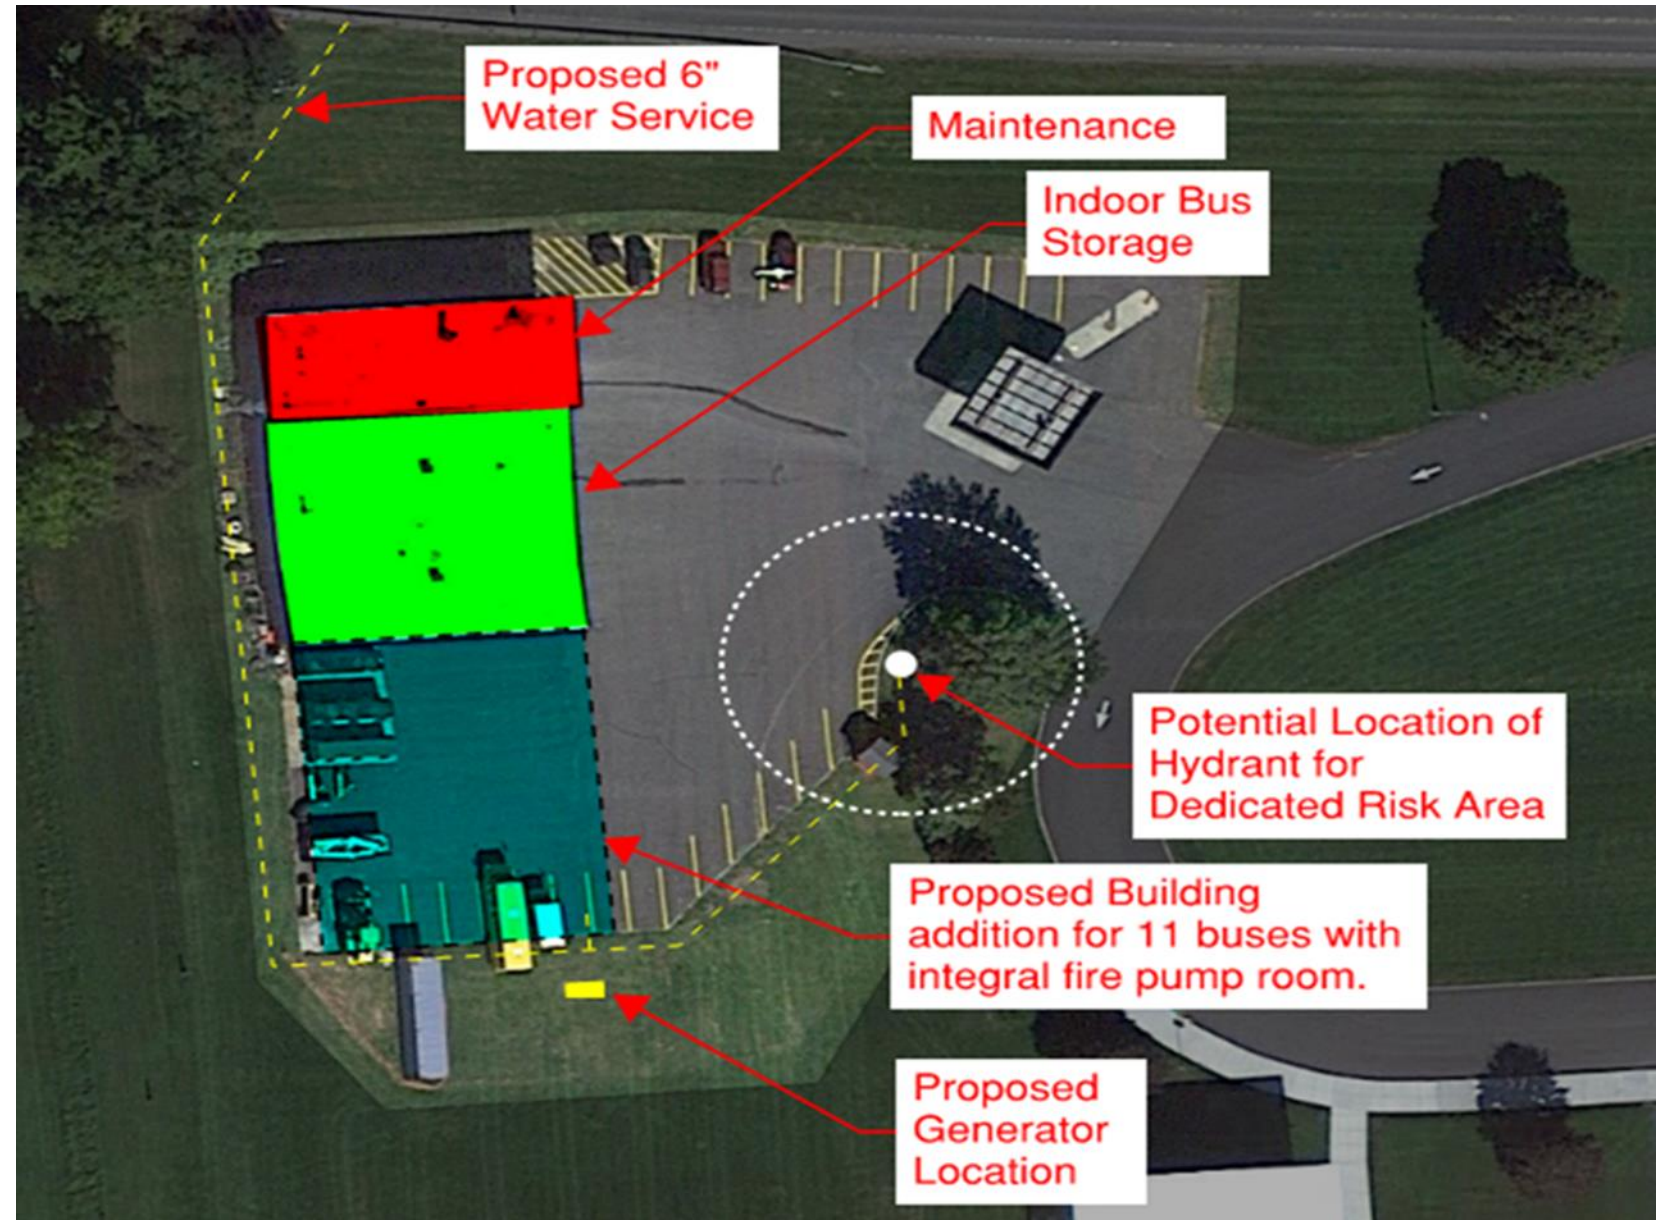
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Date	07/31/2024
Drawing Number	E2





CONCEPTUAL - NOT FOR CONSTRUCTION

Phase 1: Fire Protection



Questions





Thank you.

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